


FRONT ELEVATION

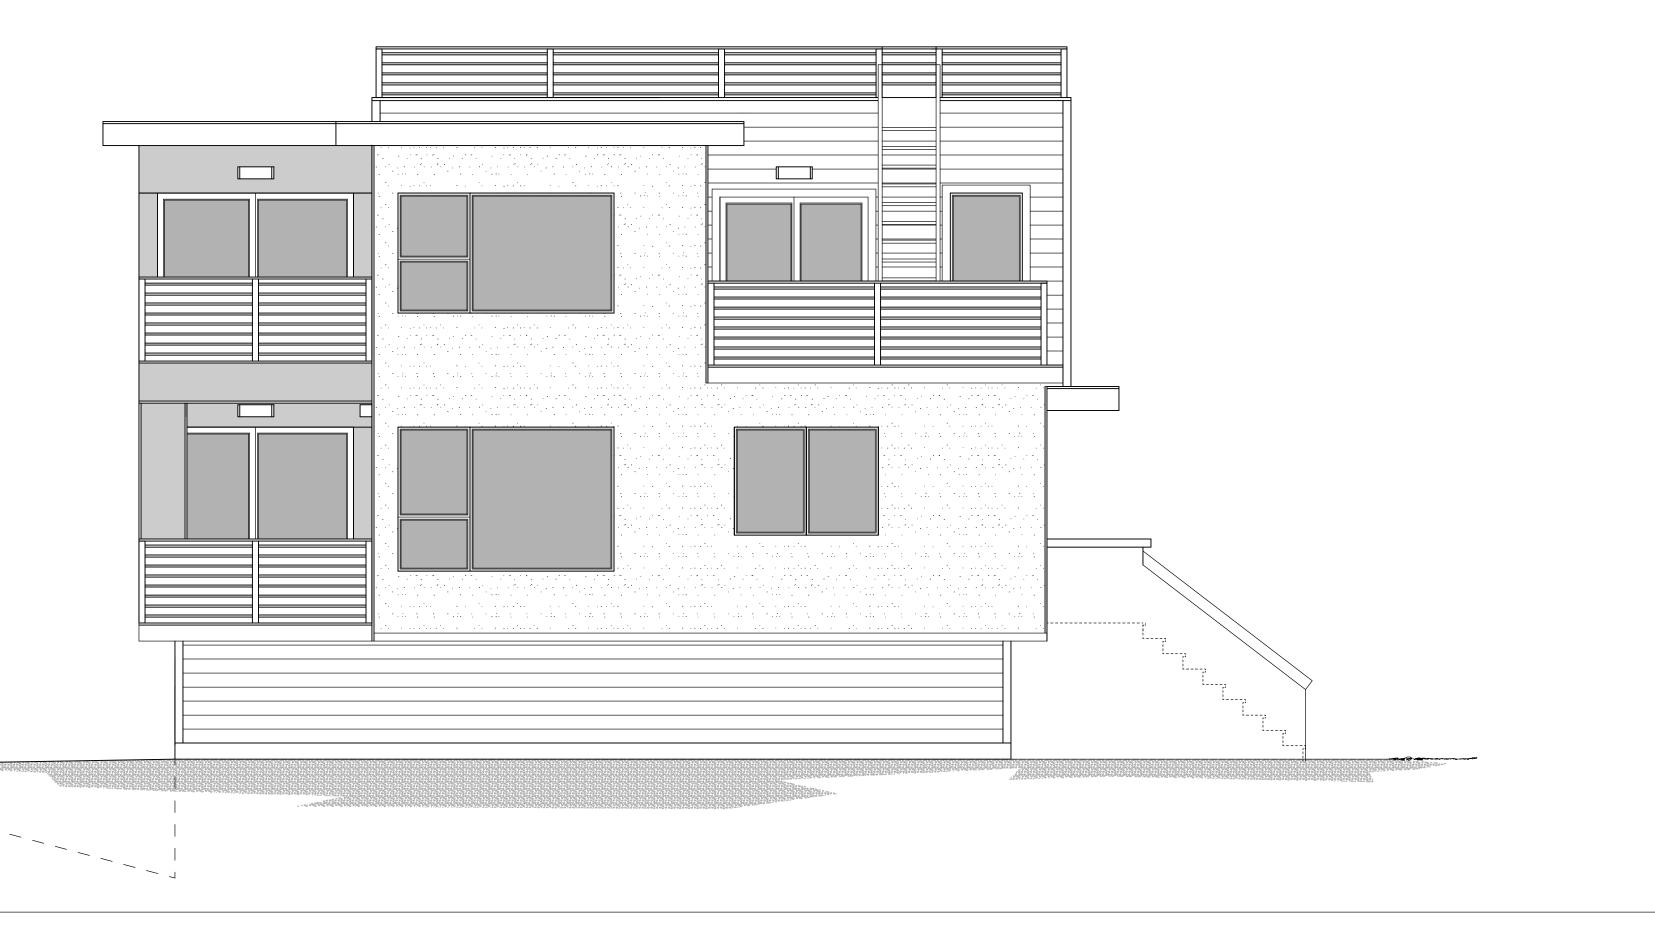

BUILDER: 5 2 A MODULAR DRAWN BY: LCL DATE: 9.1.18 SCALE: 1/4" = 1'-0" REVISIONS: DESCRIPTION: STAMP

X

SERIAL #


QUOTE #

/\

DESCRIPTION: ELEVATIONS

SHEET TITLE:

ALL DRAWINGS AND WRITTEN MATERIAL APPEARING HEREIN CONSTITUTE ORIGINAL AND UNPUBLISHED WORK OF POWERHOUSE DESIGN GROUP AND MAY NOT BE DUPLICATED, USED OR DISCLOSED WITHOUT WRITTEN CONSENT OF GAEA DESIGN.

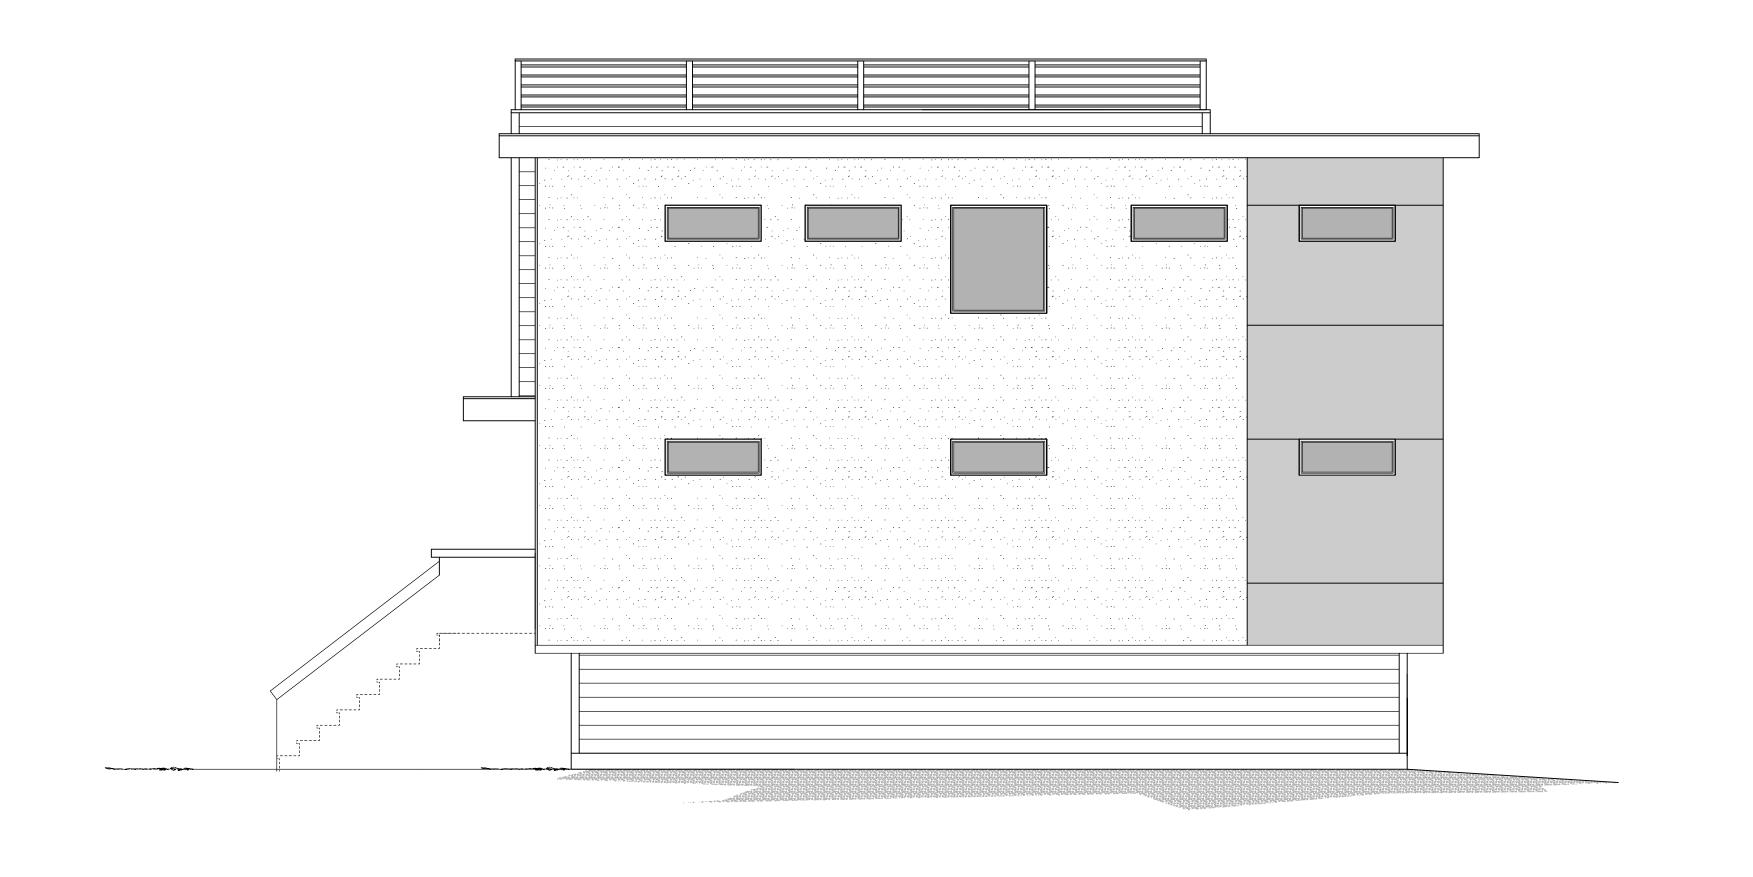


LEFT ELEVATION



REAR ELEVATION

DRAWN BY: LCL DATE: 9.1.18 SCALE: 1/4" = 1'-0" REVISIONS: NO: DATE: DESCRIPTION: 1. STAMP SERIAL # X DESCRIPTION: ELEVATIONS SHEET TITLE:	٤		VANCED CONSTRUCTION
DRAWN BY: LCL DATE: 9.1.18 SCALE: 1/4" = 1'-0" REVISIONS: NO: DATE: DESCRIPTION: 1. STAMP QUOTE # SERIAL # DESCRIPTION: ELEVATIONS			
DRAWN BY: LCL DATE: 9.1.18 SCALE: 1/4" = 1'-0" REVISIONS: NO: DATE: DESCRIPTION: 1. STAMP QUOTE # X DESCRIPTION: ELEVATIONS			
DRAWN BY: LCL DATE: 9.1.18 SCALE: 1/4" = 1'-0" REVISIONS: NO: DATE: DESCRIPTION: 1. STAMP QUOTE # X DESCRIPTION: ELEVATIONS	NOLLION		
DRAWN BY: LCL DATE: 9.1.18 SCALE: 1/4" = 1'-0" REVISIONS: NO: DATE: DESCRIPTION: 1. STAMP QUOTE # SERIAL # DESCRIPTION: ELEVATIONS	CONSTE	O	
DRAWN BY: LCL DATE: 9.1.18 SCALE: 1/4" = 1'-0" REVISIONS: NO: DATE: DESCRIPTION: 1. STAMP QUOTE # X DESCRIPTION: ELEVATIONS	E: DULAR	100EL	
DRAWN BY: LCL DATE: 9.1.18 SCALE: 1/4" = 1'-0" REVISIONS: NO: DATE: DESCRIPTION: 1. STAMP QUOTE # X DESCRIPTION: ELEVATIONS	JECT NAMI	SLA N	
DATE: 9.1.18 SCALE: 1/4" = 1'-0" REVISIONS: NO: DATE: DESCRIPTION: 1. STAMP QUOTE # SERIAL # DESCRIPTION: ELEVATIONS			
REVISIONS: NO: DATE: DESCRIPTION: 1. STAMP QUOTE # SERIAL # DESCRIPTION: ELEVATIONS			
NO: DATE: DESCRIPTION: 1. QUOTE # SERIAL # DESCRIPTION: ELEVATIONS	SCALE	: 1/4" = 1'	-0"
1. STAMP QUOTE # SERIAL # DESCRIPTION: ELEVATIONS			
QUOTE # X SERIAL # X DESCRIPTION: ELEVATIONS	-	DATE	DESCRIPTION:
QUOTE # X SERIAL # X DESCRIPTION: ELEVATIONS			
QUOTE # X SERIAL # X DESCRIPTION: ELEVATIONS			
QUOTE # X SERIAL # X DESCRIPTION: ELEVATIONS			
QUOTE # X SERIAL # X DESCRIPTION: ELEVATIONS			
QUOTE # X SERIAL # X DESCRIPTION: ELEVATIONS			
SERIAL # DESCRIPTION: ELEVATIONS	3 I AIV	IF	
SERIAL # DESCRIPTION: ELEVATIONS			
SERIAL # DESCRIPTION: ELEVATIONS			
SERIAL # DESCRIPTION: ELEVATIONS			
SERIAL # DESCRIPTION: ELEVATIONS	QUOTE		\
DESCRIPTION: ELEVATIONS		/	<u>X</u>
ELEVATIONS	SERIAI	- # \	X
	DESCR	IPTION:	
SHEET TITLE:		ELEV	ATIONS
	SHEET	TITLE:	-)
			_ (

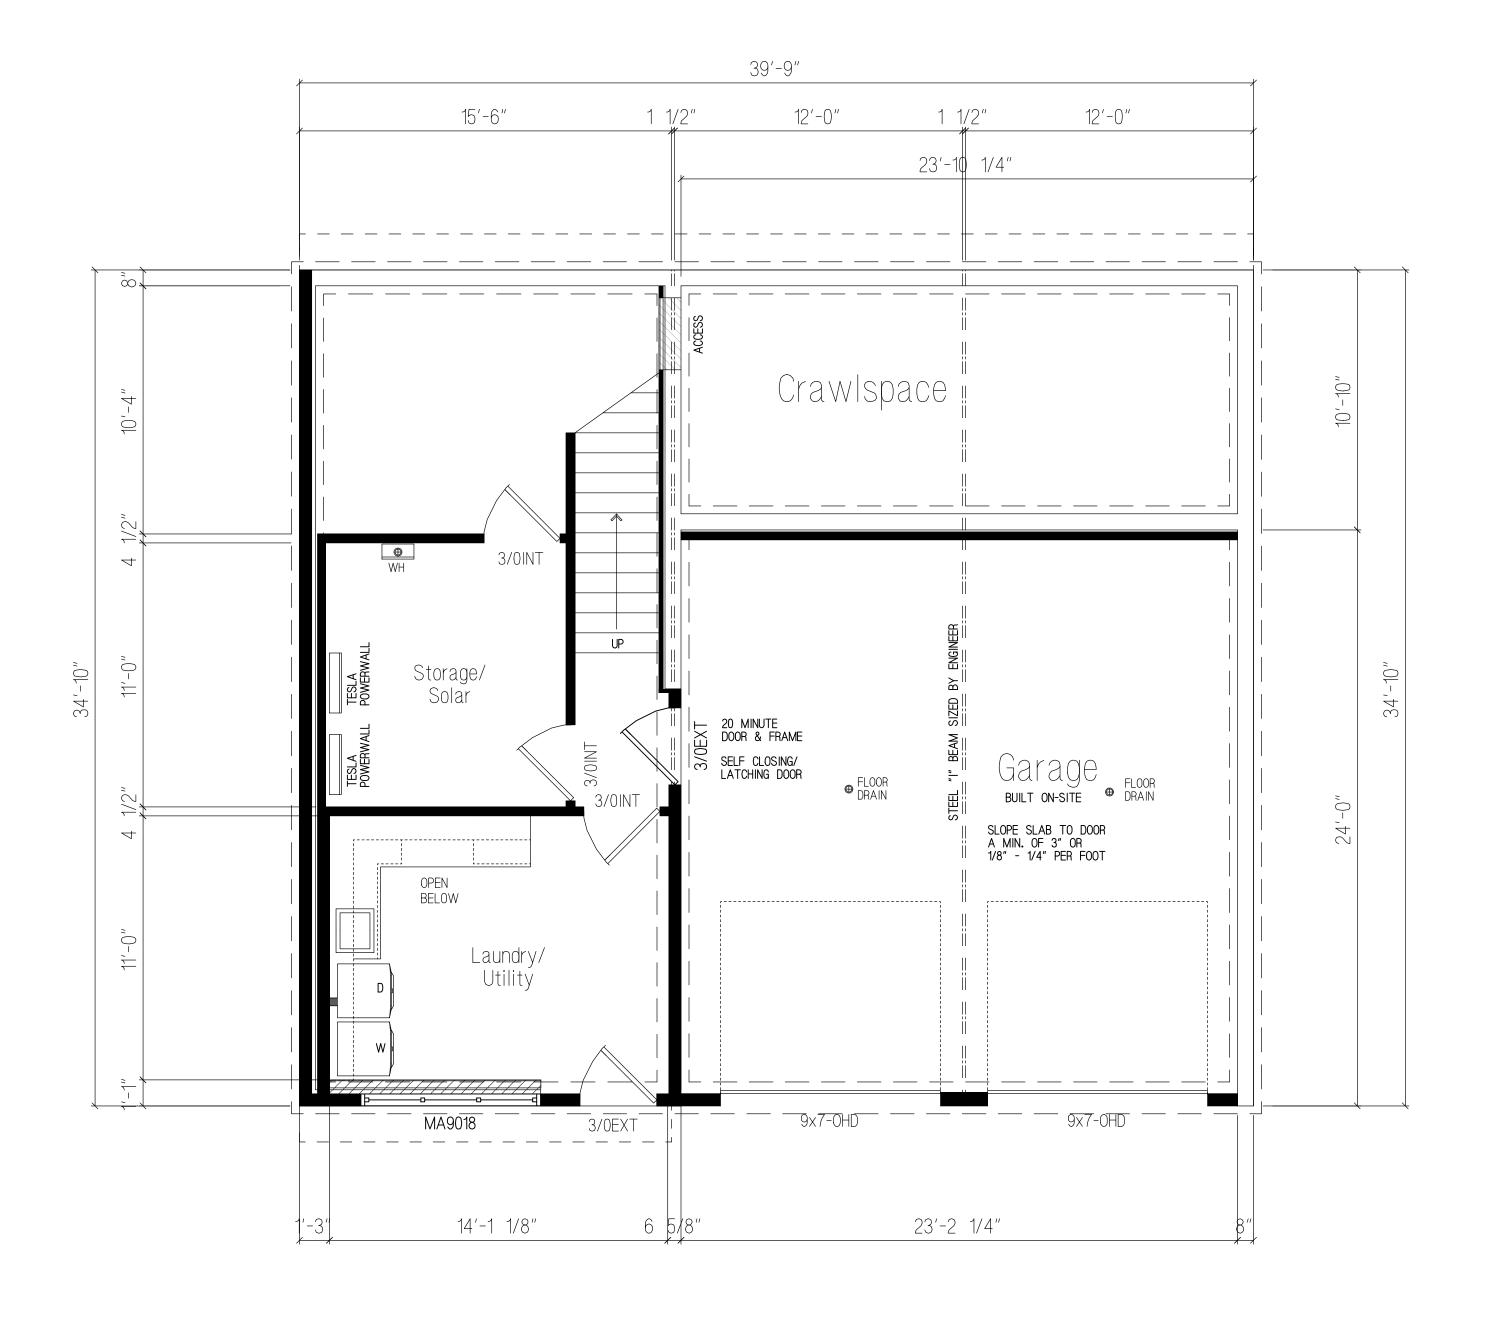

GARAGE LEVEL FLOORPLAN

457.50 SQ. FT. GARAGE LEVEL LIVING AREA 1,268.45 SQ. FT. MAIN LEVEL LIVING AREA 1,109.18 SQ. FT. UPPER LEVEL LIVING AREA 2,756.32 SQ. FT. TOTAL LIVING AREA 572.50 SQ. FT. GARAGE AREA

DRAWN BY: LCL DATE: 9.1.18 SCALE: 1/4'' = 1'-0''REVISIONS: DESCRIPTION: STAMP QUOTE # SERIAL # DESCRIPTION: GARAGE LEVEL FLOORPLAN SHEET TITLE:

BUILDER:

5 2 A MODULAR

= FACTORY BUILT WOOD FRAMED WALLS (TYP.)

= 1/2-WALLS

= SITE BUILT WALLS

10'

GENERAL NOTES:


- 1. LABELS PER PRINT.
- 2. THE SUPPORT AND FIRE STOPPING FOR FLUES AND DUCTS FOR SITE INSTALLED HEATING SYSTEMS, WATER HEATERS, FIREPLACES, ETC. SHALL BE INSTALLED BY OTHERS.
- 3. THIS HOME MAY BE BUILT PARTIALLY OR COMPLETELY REVERSED.
- 4. ALL HALLWAYS ARE 36" MIN. IN WIDTH.
- 5. FURNACE, WATER HEATER, AND VENTS MAY BE SITE INSTALLED. (COMBUSTION AIR & FRESH AIR TO BE SUPPLIED ON SITE BY OTHERS.
- 6. ALL FIREPLACES TO BE INSTALLED PER MANUFACTURERS SPECIFICATIONS AND BE PROVIDED WITH GLASS DOORS.
- 7. ALL HOSE BIBS AND LAWN SPRINKLER SYSTEMS SHALL HAVE BACKFLOW PREVENTION DEVICES.
- 8. ALL SHOWER AND BATHTUB SLIDING OR SWINGING DOORS SHALL BE TEMPERED.
- 9. PROVIDE OUTSIDE COMBUSTION AIR AT EXTERIOR WALL AT ALL FIREPLACES.
- 10. BATHTUB AND SHOWER FLOORS AND WALLS SHALL
 BE FINISHED WITH A NONABSORBENT SURFACE
 UP TO A HEIGHT OF 6'-0" ABOVE THE FLOOR
 PER CRC 307.2.
- 11. EXTERIOR LIGHTS MAY BE SHIPPED LOOSE FOR ON-SITE INSTALLATION BY OTHERS.
- 12. SIDING FOR ENDS IS SHIPPED LOOSE FOR ON-SITE INSTALLATION BY OTHERS.
- 13. BOTTOM ROW OF SIDING MAY BE SHIPPED LOOSE FOR ON-SITE INSTALLATION BY OTHERS.
- 14. SMOKE ALARMS/DETECTORS SHALL BE HARDWIRED INTERCONNECTED, AND HAVE BATTERY BACK-UP.

FLOORS: A = 15'-6" X 37'-10" B = 12'-0" X 28'-1 1/2" C = 12'-0" X 28'-1 1/2" D = 15'-6" X 37'-10" E = 12'-0" X 47'-1 1/2" SAWBOX

FLOORS: MAIN FLOOR - 2X10, 16" O.C. 9'-0" CEILING HGT. SECOND FLOOR - 11 1/4" OPEN WEB JOISTS, 16" O.C. 8'-0" CEILING HGT.


TP/ THIRD PARTY INSPECTOR INSIGNIA


STATE LABEL

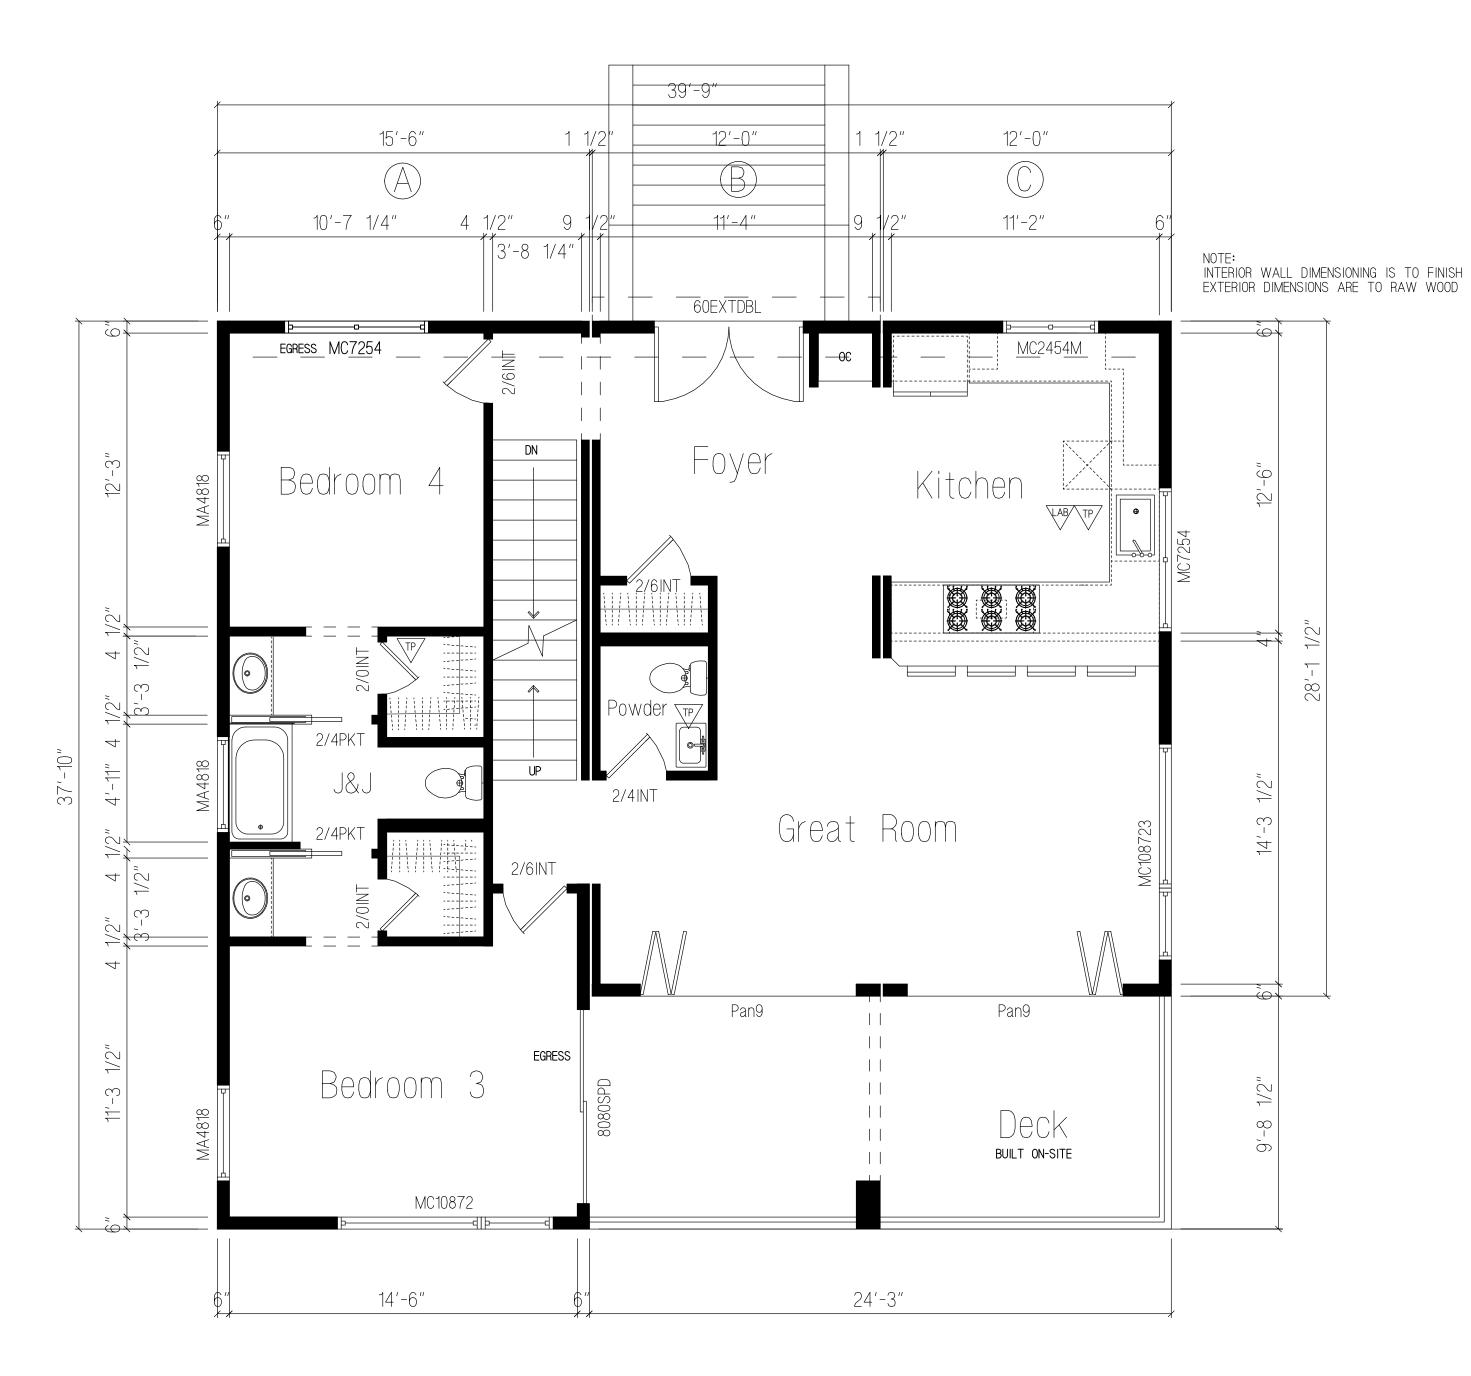


IMAIN LEVEL FLOORPLAN

1,268.45 SQ. FT. MAIN LEVEL LIVING AREA

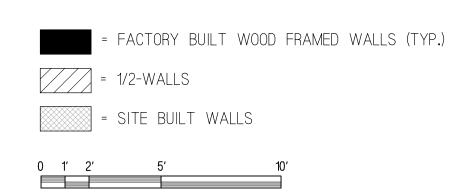

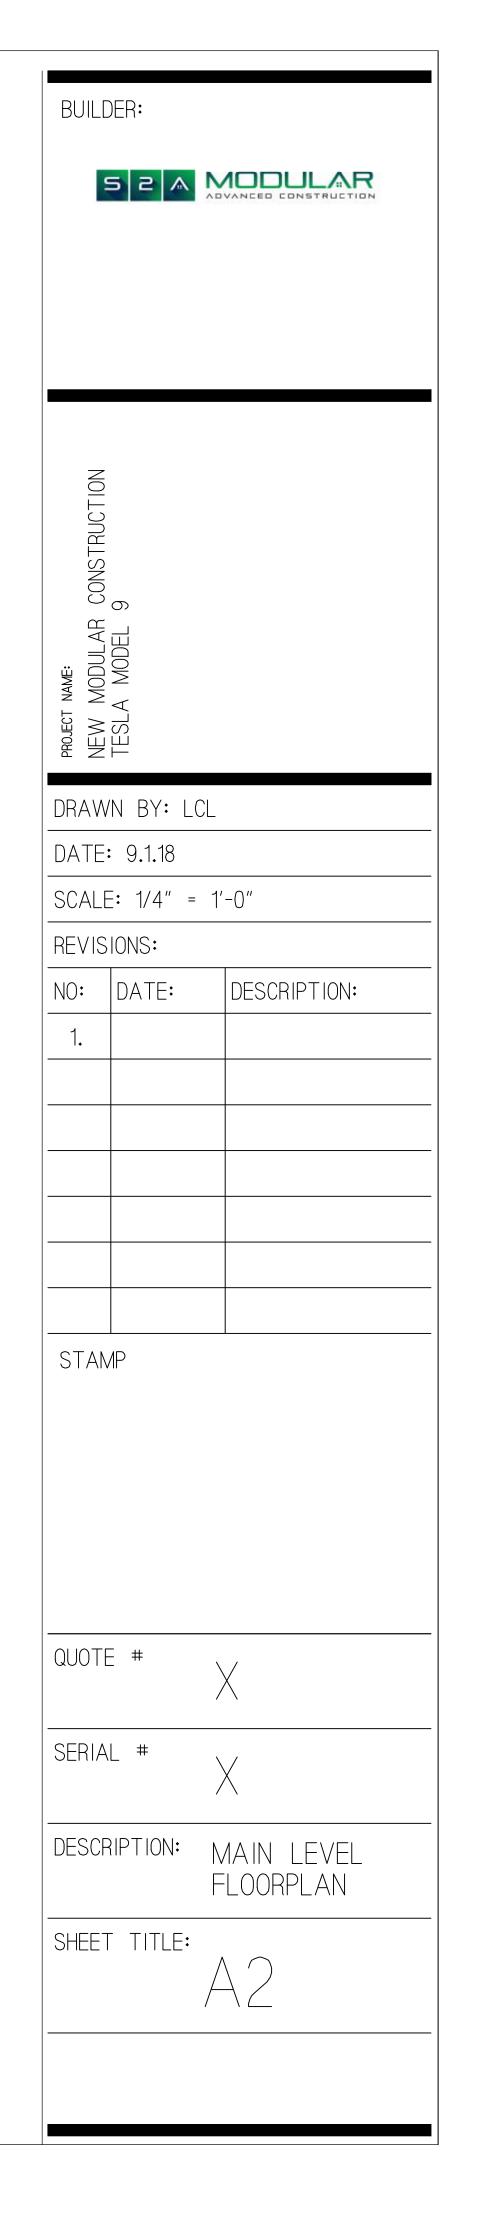

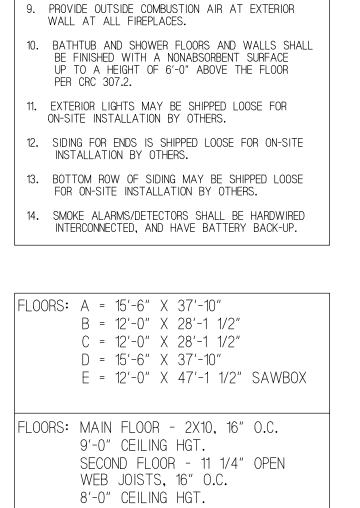

TP/ THIRD PARTY INSPECTOR INSIGNIA

STATE LABEL

GENERAL NOTES:

INSTALLED BY OTHERS.

2. THE SUPPORT AND FIRE STOPPING FOR FLUES
AND DUCTS FOR SITE INSTALLED HEATING SYSTEMS,
WATER HEATERS, FIREPLACES, ETC. SHALL BE

3. THIS HOME MAY BE BUILT PARTIALLY OR COMPLETELY REVERSED.

5. FURNACE, WATER HEATER, AND VENTS MAY BE SITE INSTALLED. (COMBUSTION AIR & FRESH AIR TO BE SUPPLIED ON SITE BY OTHERS.

Y. ALL HOSE BIBS AND LAWN SPRINKLER SYSTEMS SHALL HAVE BACKFLOW PREVENTION DEVICES.


B. ALL SHOWER AND BATHTUB SLIDING OR SWINGING

4. ALL HALLWAYS ARE 36" MIN. IN WIDTH.

6. ALL FIREPLACES TO BE INSTALLED PER MANUFACTURERS SPECIFICATIONS AND BE PROVIDED WITH GLASS DOORS.

DOORS SHALL BE TEMPERED.

1. LABELS PER PRINT.

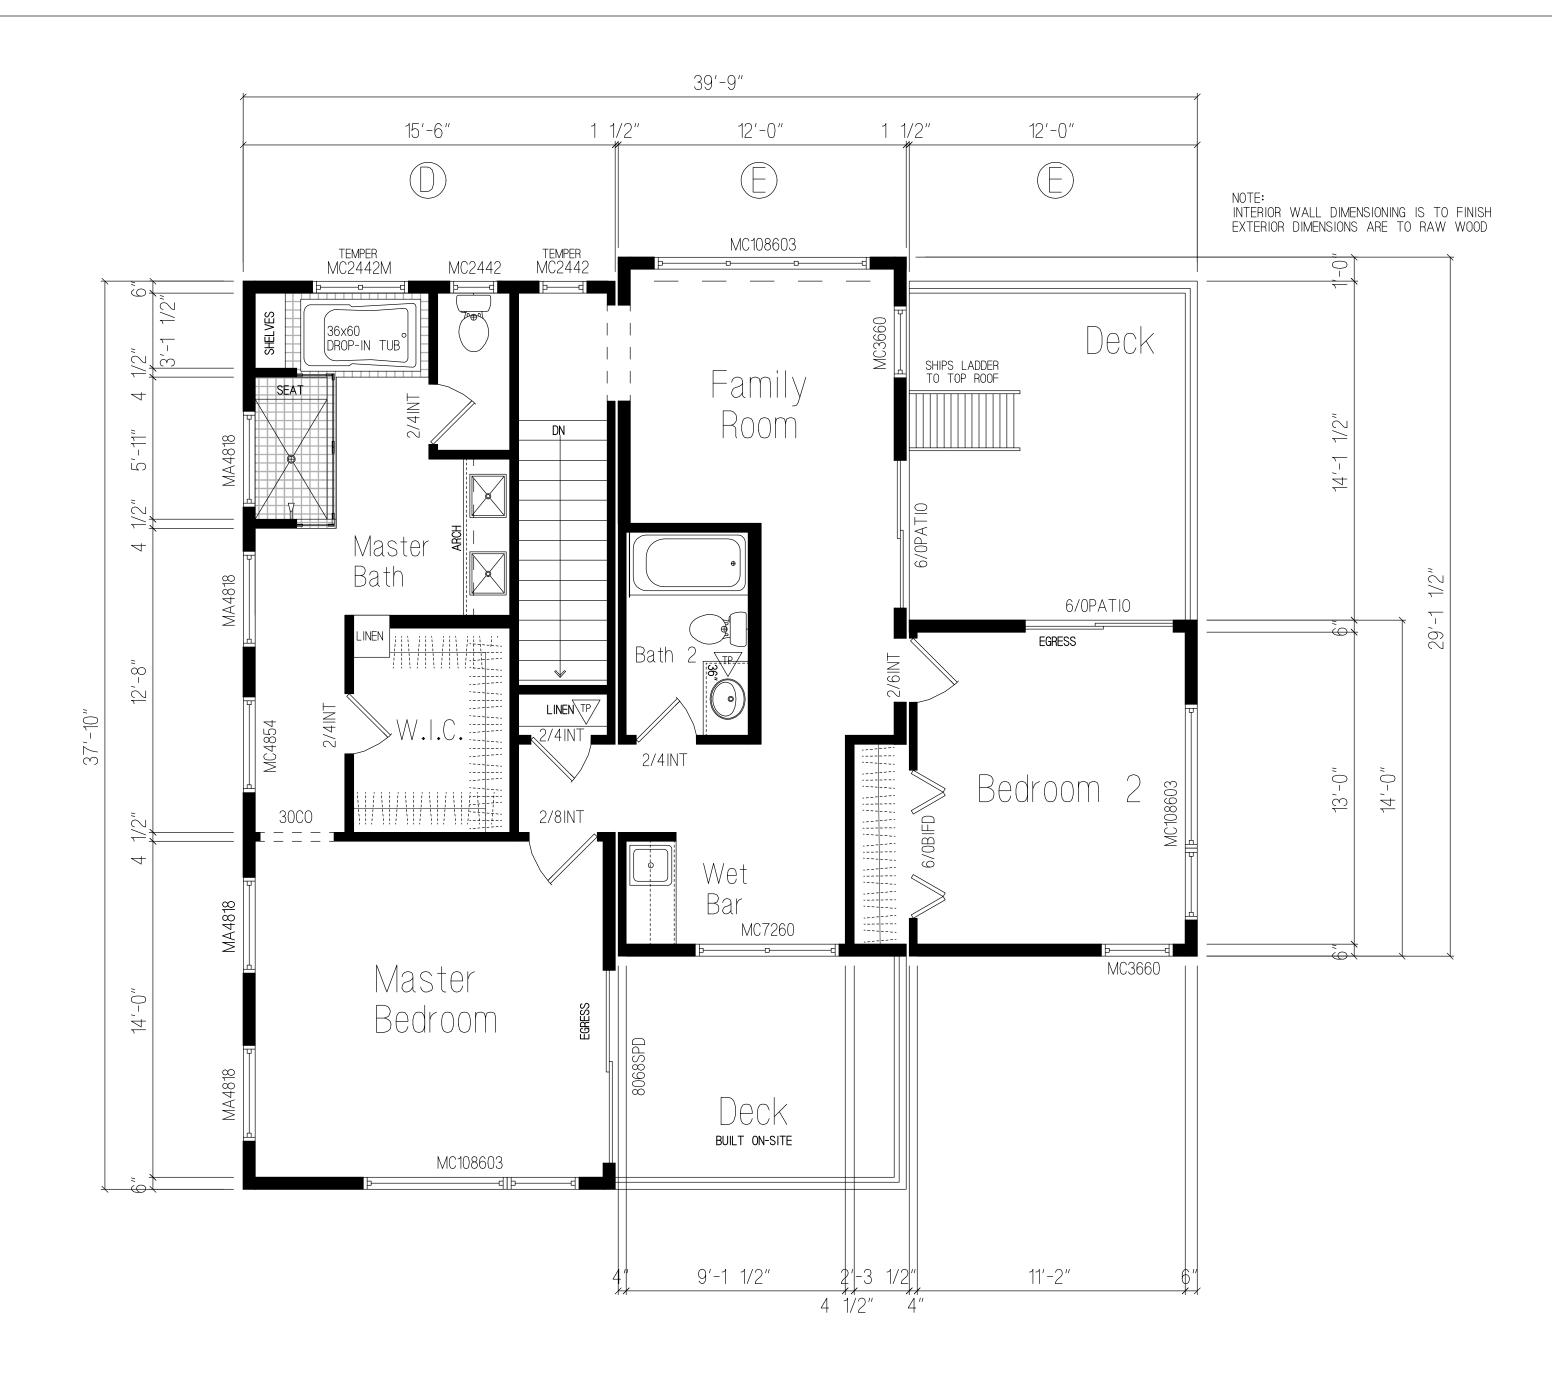

UPPER LEVEL FLOORPLAN

1,109.18 SQ. FT. UPPER LEVEL LIVING AREA

= FACTORY BUILT WOOD FRAMED WALLS (TYP.)

= 1/2-WALLS
= SITE BUILT WALLS

0 1' 2' 5' 10'

PROJECT NEW TESLA DRAWN BY: LCL DATE: 9.1.18 SCALE: 1/4" = 1'-0" REVISIONS: DESCRIPTION: STAMP QUOTE # SERIAL # DESCRIPTION: UPPER LEVEL FLOORPLAN SHEET TITLE:

BUILDER:

5 2 A MODULAR